


VICINITY MAP

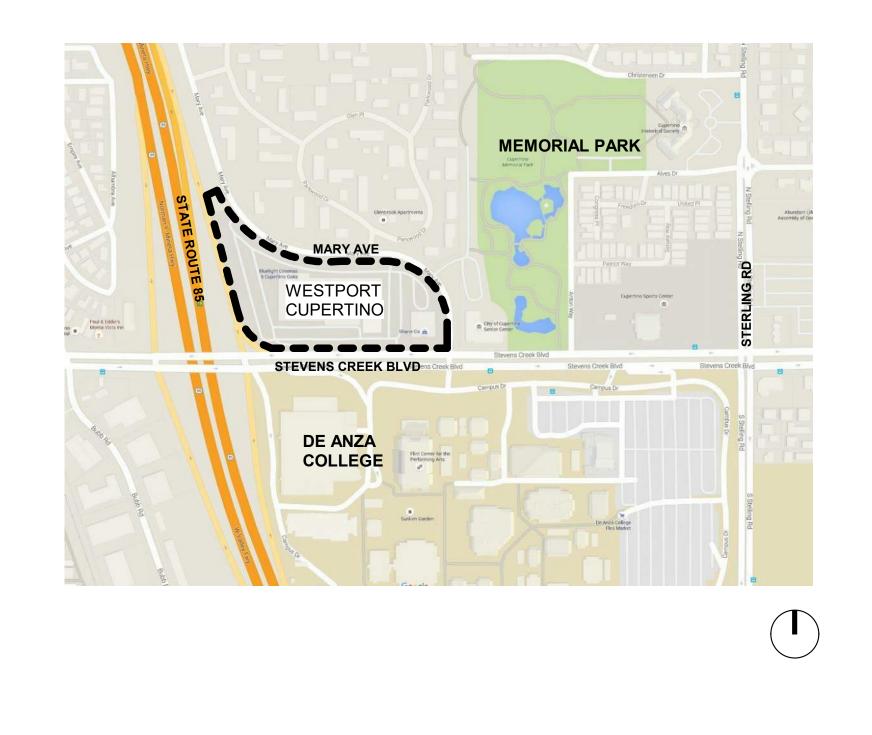

## PROJECT TEAM

## CLIENT

KT URBAN 21710 STEVENS CREEK BLVD #200 CUPERTINO, CA 95104 P: 408.257.2100 CONTACT: MARK TERSINI

## ARCHITECT

C2K ARCHITECTURE INC. 1645 NW HOYT ST PORTLAND, OR 97209 P: 503.244.2100 CONTACT: KEVIN SAUSER <u>ksauser@c2karch.com</u> CONTACT/APPLICANT: NATHAN MILLER nmiller@c2karch.com

### CIVIL

KIMLEY-HORN 4637 CHABOT DRIVE SUITE 300 PLEASANTON, CA 94588 P: 925.965.7701 CONTACT: MARK FALGOUT Mark.Falgout@kimley-horn.com

## LANDSCAPE

PLACE 735 NW 18TH AVE PORTLAND, OR 97209 P: 503.334.1630 CONTACT: MIGUEL CAMACHO SERNA miguel.camacho.serna@place.la

:04:28 PM

## DRAWING INDEX

	DRAWING INDEX	
GENER	AL	Al
G201	ILLUSTRATIVE SITE PLAN	A
G202	PROJECT SUMMARY	A
G203	SITE SETBACKS	A
G204	SLOPE SETBACKS	A
G206	OPEN SPACE AREAS	A
G207	NEIGHBORHOOD SITE PLAN & BUILDING HEIGHTS	A
G213	PROPOSED MATERIALS	A
G300	TRUCK & GARBAGE ROUTES	A
		A
CIVIL		A
C0	EXISTING CONDITIONS	A
C1	PRELIMINARY GRADING PLAN	A
C2	PRELIMINARY STORMWATER CONTROL PLAN	A
C3	PRELIMINARY DETAILS AND SECTIONS	A
		A
LANDS		A
L.100	LANDSCAPE PLAN	A
L.200	PLANTING PLAN	A
L.300	TREE ASSESSMENT PLAN	

ARCHIT	ECTURAL
A001	SITE PLAN
A200	LEVEL B1 PLAN
A201	LEVEL 1 PLAN
A202	LEVEL 2 PLAN
A203	LEVEL 3 TOWNHOUSES / R
A206	LEVEL 6 PLAN
A210	ELEVATIONS - SITE
A211	SECTIONS - SITE
A212	TYPOLOGICAL PRECEDEN
A213	<b>ELEVATIONS - BLDG 1</b>
A214	<b>ELEVATIONS - BLDG 1</b>
A216	<b>ELEVATIONS - BLDG 2</b>
A217	SECTIONS - BLDG 1 AND 2
A220	ELEVATION AND SECTION
A221	ELEVATION AND SECTION
A222	ELEVATION AND SECTION
A223	FLOOR PLANS - TOWHOUS
A240	PHASING PLAN

## DRAWING INDEX

ROWHOUSES, LEVELS 3-5 BLDG 1, LEVELS 3-4 BLDG

TOWNHOUSE (6) TOWNHOUSE (4) ROWHOUSE JSES AND ROWHOUSES ATION APPLIC AN Ц

SHEET TITLE: **COVER SHEET** 

SHEET NO.: G200

PRELIMINARY, NOT FOR CONSTRUCTION

REPRODUCTION OF THIS DRAWING IS EXPRESSLY FORBIDDEN WITHOUT THE SPECIFIC WRITTEN PERMISSION OF C2K ARCHITECTURE INC. THIS DRAWING IS ONLY CONDITIONALLY ISSUED, AND NEITHER RECEIPT OR POSSESSION THEREOF CONFERS OR TRANSFERS ANY RIGHT TO, OR LICENSE TO, USE THE SUBJECT MATTER OF THIS DRAWING OR ANY TECHNICAL INFORMATION SHOWN THEREON, NOR ANY RIGHT TO REPRODUCE THIS DRAWING OR PART THEREOF, WITHOUT THE WRITTEN AUTHORIZATION OF C2K ARCHITECTURE INC.

REVISION: DESCRIPTION:

PROJECT NO.: 14148 DRAWN: Author 2018 MAY 17 DATE: SITE PLAN APPLICATION

## 21267 STEVENS CREEK **BLVD, CUPERTINO, CA**

**KT URBAN** 

## WESTPORT **CUPERTINO**

Г	 —	—	—	—	—	—	—	—	—	—	٦
I											
I											
1											
I											
I											
I											
1											
, I											
1											
I											
I											
I											I
1											I
1											
L (	STAM		—	—	—	—	—	—	—	—	







Ш


SIT

SHEET TITLE: ILLUSTRATIVE SITE PLAN







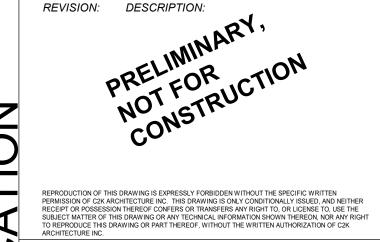

REVISION: DESCRIPTION:


PROJECT NO.: 14148

DRAWN: Author 2018 MAY 17 DATE: SITE PLAN APPLICATION

21267 STEVENS CREEK **BLVD, CUPERTINO, CA** 

KT URBAN

## WESTPORT **CUPERTINO**

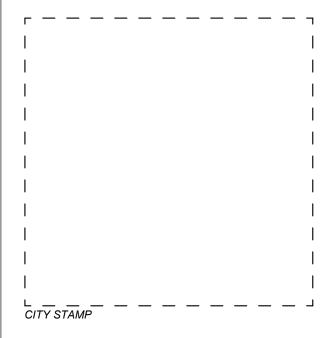





## **BUILDING CODE DATA (CONT.)**:

### 4. OCCUPANT LOAD: BUILDING 1: RETAIL: **BUILDING 2: RETAIL:**

BUILDING 1: RESID: BUILDING 2: RESID:

TOWNHOUSES: **ROWHOUSES:** 

PARKING GARAGE:

275 OCCUPANTS **59 OCCUPANTS** 710 OCCUPANTS **133 OCCUPANTS** 207 OCCUPANTS **57 OCCUPANTS** 440 OCCUPANTS 16.500 GSF/ 60 GSF PER OCC 3.500 GSF/ 60 GSF PER OCC.

141.855 GSF/ 200 GSF PER OCC. 26,550 GSF/ 200 GSF PER OCC.

69 UNITS \* 3 BEDROOMS 19 UNITS \* 3 BEDROOMS

88,000 GSF/ 200 GSF PER OCC.

## **RESIDENTIAL UNIT MATRIX:**

RESIDENTIAL -RETAIL BUILDING 1						
UNIT MIX	1 BR	2BR	3BR	TOTAL		
LEVEL 6		4	3	7		
LEVEL 5	7	12	1	20		
LEVEL 4	7	12	1	20		
LEVEL 3	7	12	1	20		
LEVEL 2	8	11		19		
LEVEL 1						
TOTAL UNITS	29	51	6	86		
RATIO %	34%	59%	7%	100%		

RESIDENTIAL - RETAIL BUILDING 2 - SENIOR LIVING UNITS					
UNIT MIX	1 BR	2BR	3BR	TOTAL	
LEVEL 4	9	0	0	9	
LEVEL 3	9	0	0	9	
LEVEL 2	9	0	0	9	
LEVEL 1	3	0	0	3	
TOTAL UNITS	30	0	0	30	
RATIO %	100%	0%	0%	100%	

SINGLE FAMILY - ROWHOUSES AND TOWNHOUSES						
	3BR / 3BA 3BR / 2.5 BA TOTAL					
ROWHOUSES	13	6		19		
TOWNHOUSES	43	26		69		
TOTAL UNITS	56	32		88		

TOTAL UNITS 204

### 6. BICYCLE PARKING:

**ZONING CODE DATA: ZONING CODE DATA (CONT.):** 1. GENERAL PLAN/ ZONING: - General Plan Guidelines Community Vision 2040, and the Heart of the - Required Bicycle Parking for Each Building Use, per Green Building Standards Non-City Specific Plan Residential Mandatory Measure 5.106.4.1.1: Title 19 - Zoning Reference Building 1: Commercial / Residential - (E) Land Use Designation: Short Term Retail (Class II) 5% of 66 Vehicle Spaces 4 Reg'd / 4 Provided - (E) Zoning Designation: P(CG/RES) - Site Area, Gross: 8.1 acres; 352,836 GSF <u>Building 2:</u> Short Term Retail (Class II) 5% of 14 Vehicle Spaces - Site Area, Net:

Required Bicycle Parking for Each Building Use, per Parking Table 19.124.040(A): Building 1 Residential (Class II) (1/ 10 units): Retail (Class II) (1/ 1,250 SF):

Building 2: Residential (Class II) (1/ 10 units): Retail (Class II) (1/ 1,250 SF):

- See architectural sheet A203 for bicycle parking locations.

### 8. PROVISIONS TO VARY FROM HEART OF THE CITY PLAN PURSUANT TO STATE **DENSITY BONUS LAW. (SEE APPLICATION)**

- Project will have 30 Below Market Rate (BMR) Affordable Senior Housing Units and requests the following provisions:
  - Density Increase from 200 to 204 housing units Height Increase for Building 1 from 45'-0" to 65'-0" Increase in the slope setback for Building 1 on Stevens Creek Boulevard

  - frontage from 1:1 to 1:1.70.

## **BUILDING CODE DATA:**

- 1. LOCAL CODES :
- 2016 California Building Standards Codes & Cupertino Municipal Code Chapter 16.04
- Retail (16,500 SF) (Uni-size): 66 Spaces Reg'd/ 66 Provided (66 at grade) - 2016 California Building Code, w/ local amendments Residential (86 units): Covered (9'-6"x20'): 86 Spaces Req'd/ 89 Provided (86 tandem and 3 single spaces in garage) 86 Spaces Reg'd/ 86 Provided (tandem in garage) Open (9'-6"x20'): Total Spaces: 238 Spaces Req'd / 241 Provided Residential-Retail Building 2 (Senior / Low Income Housing): Retail (3,500 SF) (Uni-size): 14 Spaces Req'd/ 14 Provided (at grade) Residential (30 units): Covered (9'-6"x20'): 30 Spaces Reg'd/ 30 Provided (tandem in garage) Open (9'-6"x20'): <u>30 Spaces Req'd/ 30 Provided (tandem in garage)</u> Total Spaces: 74 Spaces Reg'd / 74 Provided ed) Residential-Townhouses / Rowhouses parated Residential (88 units): parated Covered (10'x20'): 176 Spaces Reg'd/ 176 Provided (in unit) n-separated 70.4 Spaces Reg'd/ 71 Provided (at grade) Open (Uni-size): n-separated Groups A-2 and M, Separated 246.4 Spaces Reg'd / 247 Provided Total Spaces: Retail Residential-: Townhouses/Rowhouses: Group R-3, Separated Future Electrical Vehicle Supply Equipment (EVSE) and Clean Air Vehicles Per CALGreen 4.106.4.1.: Each Townhouse / Rowhouse will have a raceway and service panel to support a 40 amp circuit for a vehicle charging station. Per CALGreen 4.106.4.2: Three percent of parking spaces in multi-family dwellings units shall be EVSE. ype IIIA SM: - Building 1/ Residential Spaces: 3% of 175 spaces = 5.25 Spaces Req'd / 6 Spaces Story allowed per Table 504.4 and Provideo w/ 3-Hr separation at the First Floor. - Building 2/ Residential Spaces: 3% of 60 spaces = 1.8 Spaces Req'd / 2 Spaces dential Building, over 1 Story Retail Provided tion 510.5 f highest roof parapet (N.I. stair and - Per CALGreen 5.106.5.3.3: Table 5.106.5.3.3 (80) retail parking spaces require 5 EVSE uns, non-occupied tower, or fall protection) Spaces / 5 Provided ry for Type VA Housing per - Building 1/ Retail Spaces: 66 Spaces = 4 EVSE Req'd / 4 Provided nd Section 506.2 - Building 2/ Retail Spaces: 16 Spaces = 1 EVSE Reg'd / 1 Provided vpe IA Retail at 29,901 SF/Story, w/ 2-Hr rated fire walls - Per CAL Green 5.106.5.2, Table 5.106.5.2 (80) retail parking spaces require 8 Clean Air sidential floor levels; Vehicle stalls / 8 Provided (per CAL Green 5.106.5.3.5, future charging stations qualify as etail Clean Air Vehicle stalls) - Per CAL Green 5.106.5.3.4, future EVSE charging stalls shall be designated as "EV vpe VA Sprinklered SM: CAPABLE" wed per Table 504.4 and Section 510.2 - Per CAL Green 5.106.5.2.1, Clean Air Vehicle stalls shall be designated as "CLEAN AIR dential Building, over 1 Story Retail / / VAN POOL / EV". le 504.3 Accessible Parking Stalls f highest roof parapet (N.I. stair and - Per 11B-Table 11B208.2 Accessible Retail Parking Stalls are: uns or fall protection) - Building 1/ Retail : 66 Spaces = 3 Accessible Spaces Reg'd / 3 Provided (1 is Van ory for Type VA Housing per space) nd Section 506.2 - Building 2/ Retail Spaces: 16 Spaces = 1 Accessible Space Req'd / 1 Provided tion between R and A / M / B occupancies (Van Space) 7464 SF/Story; - Per 1109A.3 - Assigned Accessible Residential Parking Stalls: - Building 1/ Residential: 2% of 175 spaces = 3.5 Spaces Reg'd / 4 Tandem Spaces (8 spaces total) provided. 1 Tandem Space shall be van accessible. Type IA: - Building 2 / Residential: 2% of 60 spaces = 1.2 Spaces Req'd / 2 Tandem Spaces ies allowed per Table 504.4 (4 spaces total) provided. 1 tandem space shall be van accessible arade - Townhouses/ Rowhouses: 2% of 176 spaces = 3.52 Spaces Req'd / 4 Tandem Table 506.2 Spaces (8 spaces total) Provided in Units. 1 Tandem Space shall be Van Accessible. - Per 1109A.5 Unassigend Visitor Spaces: - Townhouses/ Rowhouses: 5% of 71 open spaces = 3.6 Spaces Reg'd / 4 Spaces VA - Sprinklered S13R: Provided. 1 Space shall be Van Accessible dential Building le 504.3 f highest roof ridge

- Accessibility
- 2016 California Electrical Code, w/ local amendments - 2016 California Mechanical Code, w/ local amendments - 2016 California Plumbing Code, w/ local amendments - 2016 California Energy Code, w/ local amendments - 2016 California Fire Code, w/ local amendments - 2016 California Green Building Standards (CALGreen) Code, w/ local amendments - 2016 California Residential, w/ local amendments - Fair Housing Safe Harbor: 2003 ICC/ANSI A117.1 - 2010 ADA Standards for Accessible Design 2. BUILDING USE AND OCCUPANCY : 3. BUILDING HEIGHTS AND AREAS : Story, Height, and Area Limitations:

Occupancy Groups (Separated	d & Non-Separate
Residential-Retail Buildings:	
Residential Units:	Group R-2, Sep
Low Income Housing:	Group R-2, Sep
Lobby/Office:	Group A-3, Non
Fit Center:	Group A-3, Non
Detail:	Croupe A 2 and

Story, Height, and Area Limitati	ons:
- Residential-Retail Building 1 - Allowable Stories: Actual Stories:	Construction Type IIIA SM: 5 Stories over 1 Story allowed per Table 504.4 and Section 510.5 w/ 3-Hr separation at the First Floor. 5 Stories Residential Building, over 1 Story Retail
Maximum Building Ht: Actual Building Height:	75'-0" per Section 510.5 73'-8" to top of highest roof parapet (N.I. stair and
Allowable Building Area:	elevator overruns, non-occupied tower, or fall protection) 24,000 SF/Story for Type VA Housing per Table 506.2 and Section 506.2
Actual Building Area:	Unlimited for Type IA Retail 158,355 GSF at 29,901 SF/Story, w/ 2-Hr rated fire walls to subdivide residential floor levels; 16,500 GSF Retail
- Residential-Retail Building 2 -	Construction Type VA Sprinklered SM:
Allowable Stories: Actual Stories:	4 Stories allowed per Table 504.4 and Section 510.2 3 Stories Residential Building, over 1 Story Retail / Residential
Maximum Building Ht: Actual Building Height:	60'-0" per Table 504.3 53'-5" to top of highest roof parapet (N.I. stair and elevator overruns or fall protection)
Allowable Building Area:	36,000+ SF/Story for Type VA Housing per Table 506.2 and Section 506.2 1 hour separation between R and A / M / B occupancies at First Floor.
Actual Building Area:	30,500 GSF at 7464 SF/Story; 3,500 GSF Retail
- Below-Grade Parking Garage	- Construction Type IA:
Allowable Stories:	Unlimited Stories allowed per Table 504.4
Actual Stories:	1 Story below grade Unlimited per Table 506.2
Actual Building Area:	97,000 GSF
- Residential-Townhouses - Cor Allowable Stories:	nstruction Type VA - Sprinklered S13R:
Allowable Stories:	4 Stories 3 Stories Residential Building
Maximum Building Heigh	•
Actual Building Height:	
Allowable Building Area:	Unlimited SF/Story for Type VA Housing per Table 506.2 and Section 506.2
Actual Building Area:	1554 SF plus 507 SF garage to 1954 SF plus 495 SF garage per townhouse / rowhouse. 2-Hr rated fire walls between individual townhouses / rowhouses

- 1 Reg'd / 1 Provided
- 8.6 Reg'd / 9 Provided 13.2 Reg'd / 14 Provided

### 3 Reg'd / 3 Provided 2.8 Reg'd / 3 Provided

- 7.9 acres; 343,958 NSF (Gross Site Area 8,878 SF for Public Roadway/Public Utilities easement) 32% (111,691 SF / 343,958 NSF) 1.68 (579.402 GSF / 343.958 NSF) 30 DUA, up to a maximum of 200 units 25.8 DUA, for a total of 204 Units (includes a state density bonus for 30 BMR units.)
- 45'-0" Max 65'-0" to eave of Building 1 (Highest Building) See Building Code Data for heights of each proposed building.

17'-8" from property line (eq. to 1/2 ht. of bldg)

17'-8" from property line (eq. to 1/2 ht. of bldg)

35'-0" from edge of curb

### 3. MINIMUM YARDS BUILDING SETBACKS : 35'-0" from edge of curb

Stevens Creek Blvd (South side): Mary Ave (East side):

- Zoning Max Allowable Height:

- See Bonus Height request below.

- Actual Project Max Height

- Mary Ave (North Side):
- Highway 85 (West Side): - See Architectural Site Plan sheet G203 for Building Setbacks dimensions.

## 4. OPEN SPACE:

- Lot Coverage:

- Allowable Density (DUA):

- Proposed Density (DUA):

- F.A.R.:

2. HEIGHT:

- See Open Space Area Calcs Site Plan sheet G206.

### 5. AUTO PARKING: - Parking for Each Building Use, per Parking Table 19.124.040(A) for Retail and Residential:

- **Residential-Retail Building 1**

## 1. STREET ADDRESS AND APN FOR SITE:

## pg 24-25 2. PROJECT PROGRAM SUMMARY:

- Residential-Retail Building 1: 6-stories; 141,855 SF residential; 86 units; w/ 16,500 SF of ground-level retail.
- spaces.
- 495 SF garage)

- General Plan Land Use Designation:
- Zoning Designation: Scale and North Arrow:
- Vicinity Map:
- Site Area:
- Lot Line Dimensions: - Proposed Program:
- Density:
- · Setbacks:
- · Site Plan, Existing:
- Site Plan, Proposed:

- Preliminary Floor Plans:

- Proposed Materials and Colors:
- Public Improvements:
- Driveways/Parking:
- Loading/Unloading Areas: Parking (Required and Proposed):
- Preliminary Landscape Plans:
- Open Space and Common Area:
- Phasing Plan:

## **PROJECT SUMMARY:**

- Street Address: 21267 Stevens Creek Boulevard, Cupertino, CA 95014 - Parcel 1 (APN:326-27-039) and Parcel 2 (APN: 326-27-040 & 041) per Map 838,

- Redevelopment of 71,254 SF Shopping Center (53,701 SF Retail, 17,503 SF Office) on 8.1 acres site, to provide mixed-use urban village with 204 residential units and 20,000 SF of retail space with the following structures:

- Residential-Retail Building 2 (Senior Housing): 4-stories; 26,550 SF residential; 30 senior units; w/ 3500 SF of ground-level retail.

- Below-Grade Parking Garage: 1-level below grade; 88,000 SF; 235 parking

- Residential Townhouses: 69 units, 3 stories, 124,039 SF Total Residential plus 34,467 SF of garage. (Unit size range: 1554 SF plus 507 SF garage to 1954 SF plus 495 SF garage)

- Residential Rowhouses: 19 units. 3 stories. 44.086 SF Total Residential plus 9477 SF of garage. (Unit size range: 1554 SF plus 507 SF garage to 1954 SF plus

### 3. PLANNING PERMIT APPLICATION PLAN CONTENT REQUIREMENTS:

- Unit / Townhouses / Rowhouses Plans:

Existing Buildings on Adjoining Properties:


Heart of the City Specific Plan Exceptions: Preliminary Grading Plans, Existing: Preliminary Grading Plans, Proposed: Preliminary Elevations, Proposed: Preliminary Architectural Renderings: Preliminary Building Cross-Sections:

See Sheet G.202 See Sheet G.202 See drawings sheets See Sheet G.000 See Sheet G.202 See Sheet C.1 See Sheet G.202 See Sheet G.202 See Sheet A.212, A.220-A.223 See Sheets G.203 & G.204 See Sheet C.0 See Sheet G.201 See Sheet G.207

See Sheets G.202 See Sheets A.200 thru A.206 See Sheet C.0 See Sheet C.1 See Sheets A.210 and A.213-A.216 See Sheets COVER, A.210 and A.213-A.222 See Sheets G.213 See Sheets A.211, A.214, A.220-A.222 See Sheets C.1 See Sheets A.200, A.201 See Sheets A.201 See Sheets G.202 and A.200 See Sheet L.100 and L.200 See Sheet G.206 See Sheet G.240



1645 NW HOYT PORTLAND OREGON 97209 503 444 2200

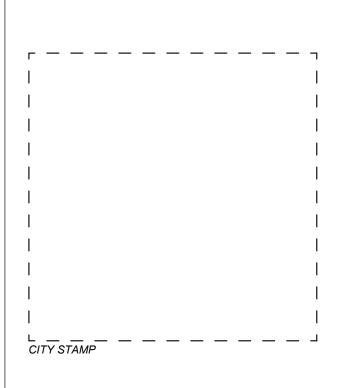

## WESTPORT **CUPERTINO**

### **KT URBAN**

## 21267 STEVENS CREEK **BLVD, CUPERTINO, CA**

PROJECT NO.: 14148 DRAWN: DATE: REVISION:

Author 2018 MAY 17 SITE PLAN APPLICATION

DESCRIPTION

TION

<

 $\Box$ 

Ц

く

Ζ

1

Ω

PRELIMINARY,


CONSTRUCTION NOTFOR

PRODUCTION OF THIS DRAWING IS EXPRESSLY FORBIDDEN WITHOUT THE SPECIFIC WRITI PERMISSION OF C2K ARCHITECTURE INC. THIS DRAWING IS ONLY CONDITIONALLY ISSUED, AND NEITHER RECEIPT OR POSSESSION THEREOF CONFERS OR TRANSFERS ANY RIGHT TO, OR LICENSE TO, USE THE SUBJECT MATTER OF THIS DRAWING OR ANY TECHNICAL INFORMATION SHOWN THEREON, NOR ANY RIGHT TO REPRODUCE THIS DRAWING OR PART THEREOF, WITHOUT THE WRITTEN AUTHORIZATION OF C2K



**PROJECT SUMMARY** 

SHEET TITLE:

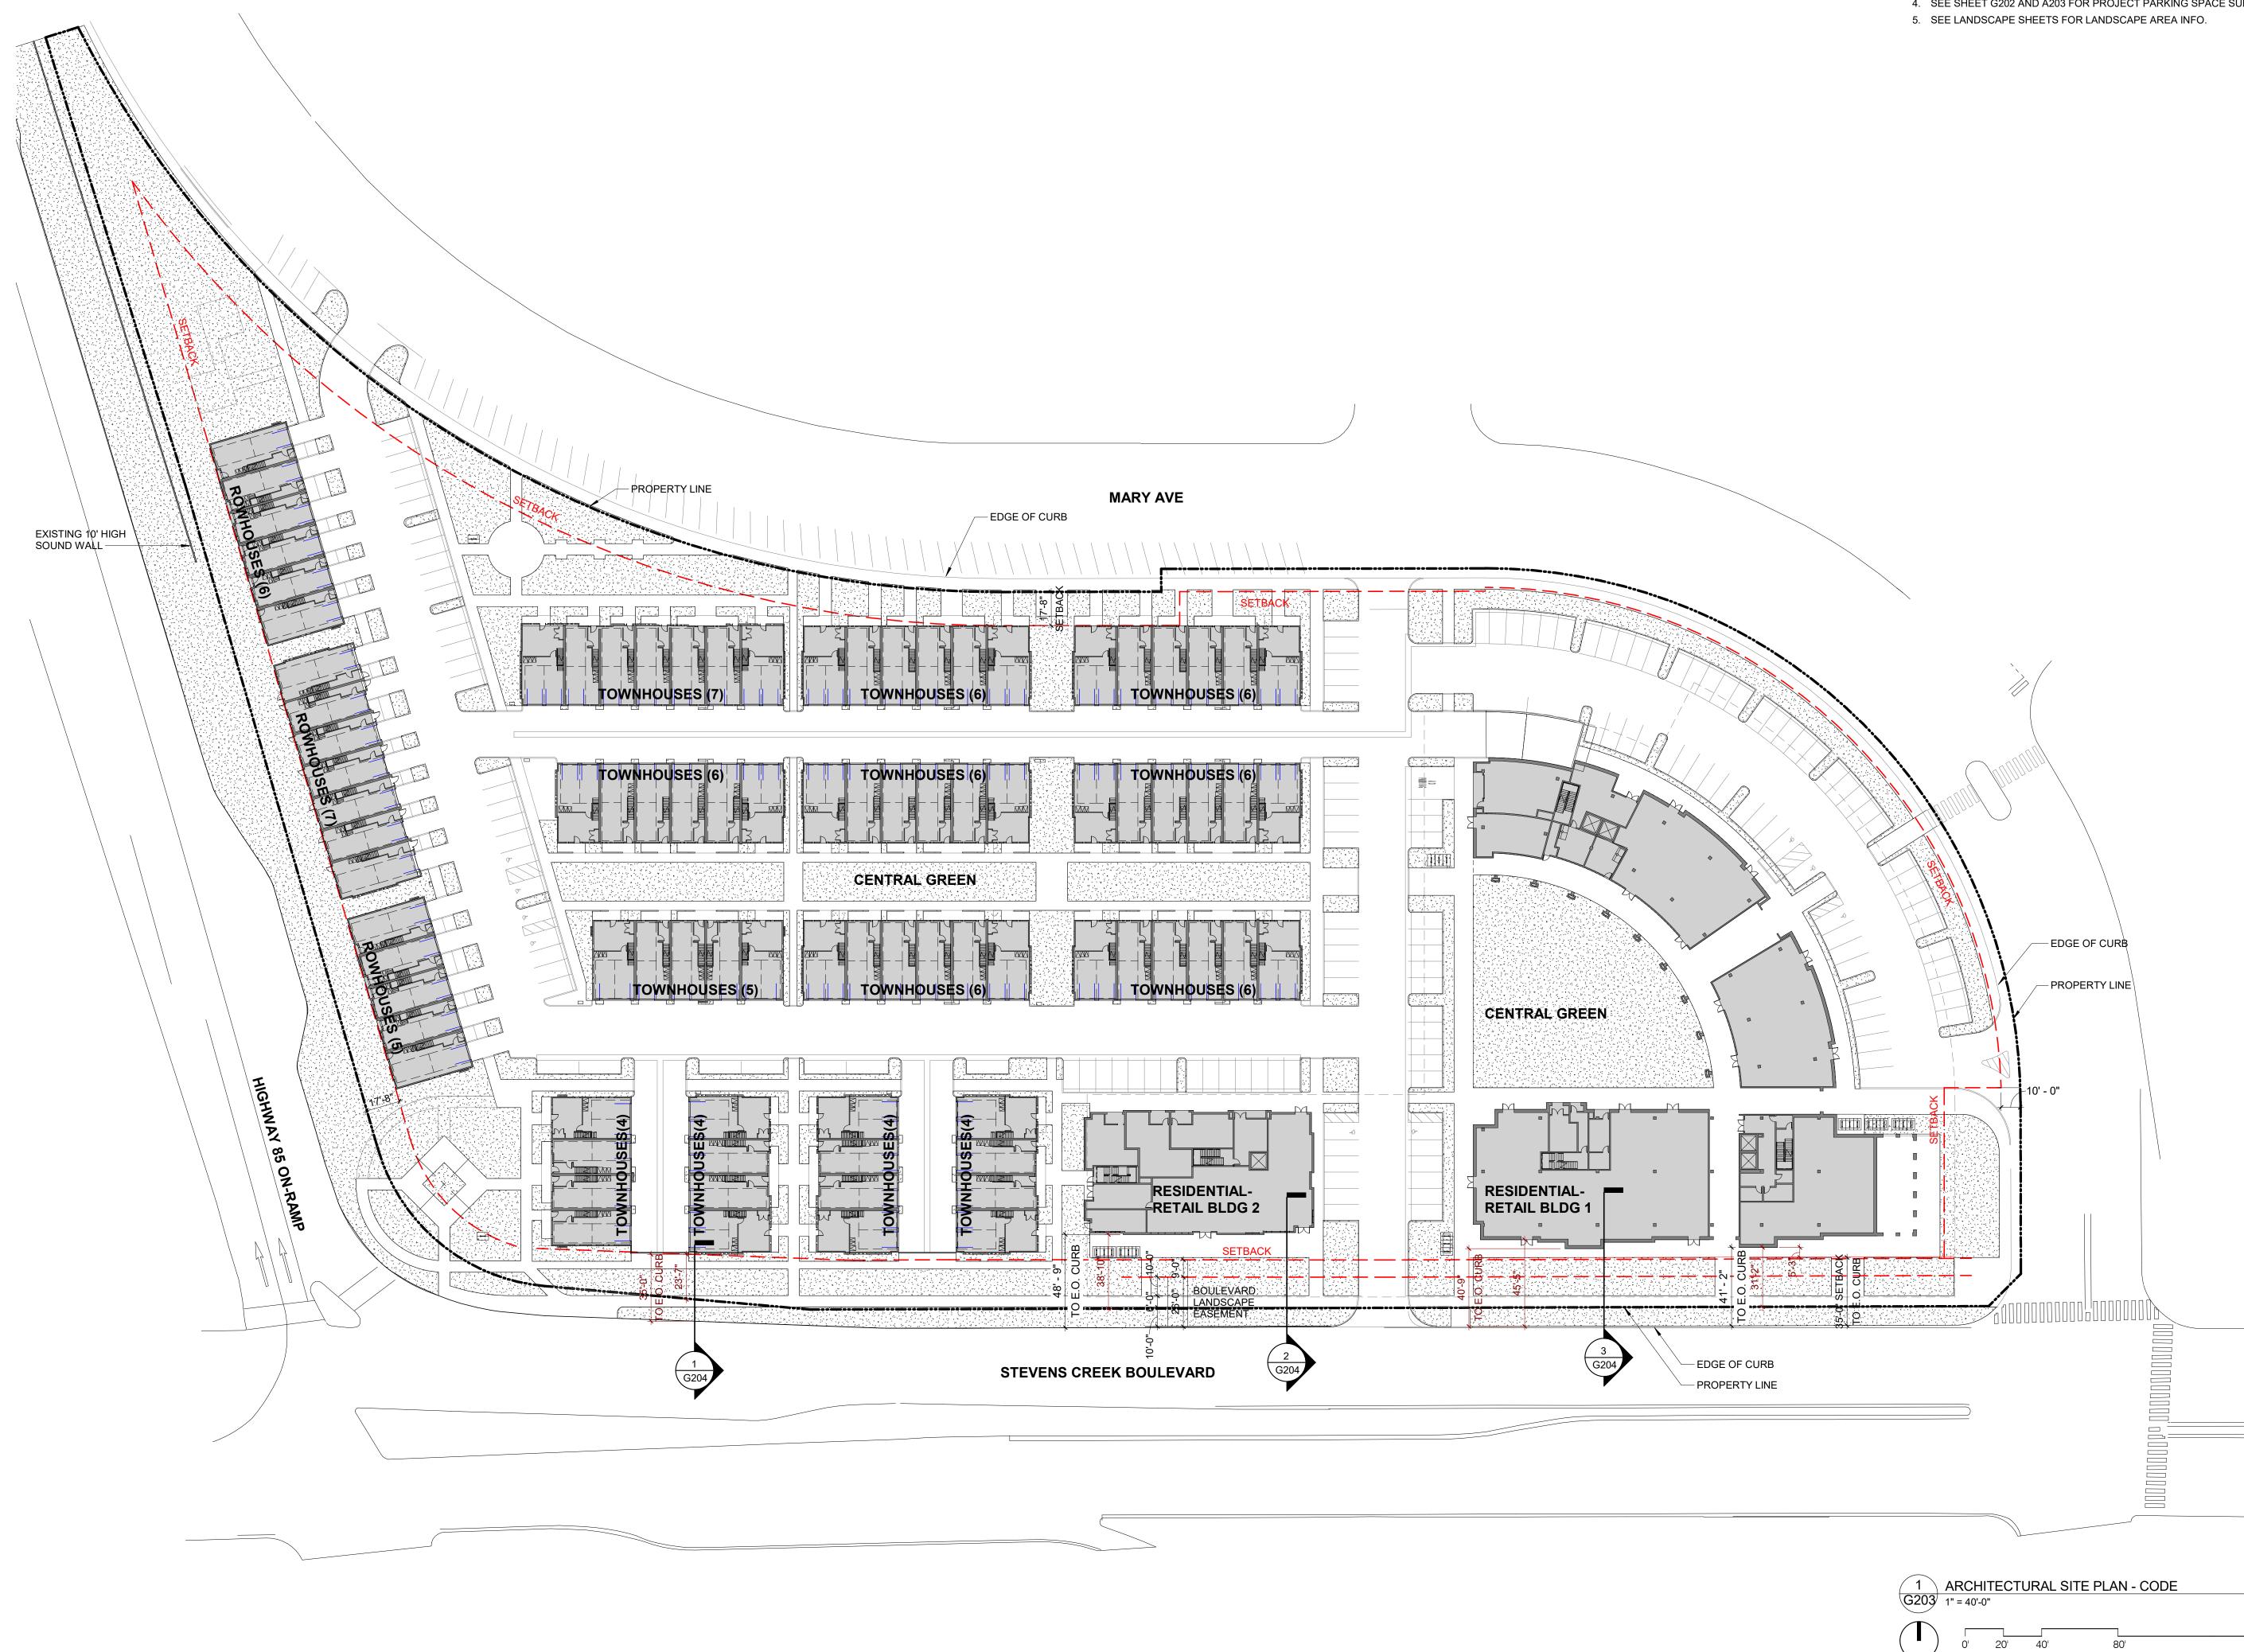

## ATION REPRODUCTION OF THIS DRAWING IS EXPRESSLY FORBIDDEN WITHOUT THE SPECIFIC WRITTEN PERMISSION OF C2K ARCHITECTURE INC. THIS DRAWING IS ONLY CONDITIONALLY ISSUED, AND NEITHER RECEIPT OR POSSESSION THEREOF CONFERS OR TRANSFERS ANY RIGHT TO, OR LICENSE TO, USE THE SUBJECT MATTER OF THIS DRAWING OR ANY TECHNICAL INFORMATION SHOWN THEREON, NOR ANY RIGHT TO REPRODUCE THIS DRAWING OR PART THEREOF, WITHOUT THE WRITTEN AUTHORIZATION OF C2K ARCHITECTURE INC. APPLIC Ζ 1 Ω SHEET NO.: G203

160'

80'

0'

SHEET TITLE: SITE SETBACKS

PRELIMINARY, NOT FOR CONSTRUCTION

DATE: REVISION: DESCRIPTION:


PROJECT NO.: 14148

DRAWN: Author 2018 MAY 17 SITE PLAN APPLICATION

## 21267 STEVENS CREEK **BLVD, CUPERTINO, CA**

KT URBAN

## WESTPORT **CUPERTINO**

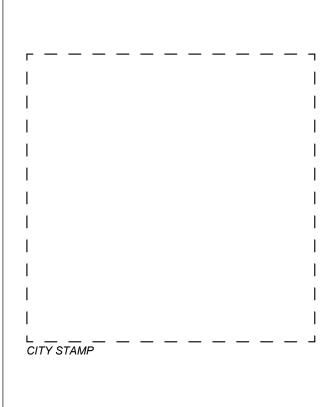

# 1645 NW HOYT


503 444 2200




- SEE PROJECT SUMMARY SHEET G202 FOR ZONING AND LAND USE DESIGNATIONS, AND GROSS SITE AREA AND NET SITE AREA.
- 2. SEE SITE PLAN SETBACKS SHEET G203 FOR SETBACK DIMENSIONS.
- 3. SEE OPEN SPACE CALCS SHEET G206 FOR OPEN SPACE CALCS.
- 4. SEE SHEET G202 AND A203 FOR PROJECT PARKING SPACE SUMMARY.




PORTLAND OREGON 97209

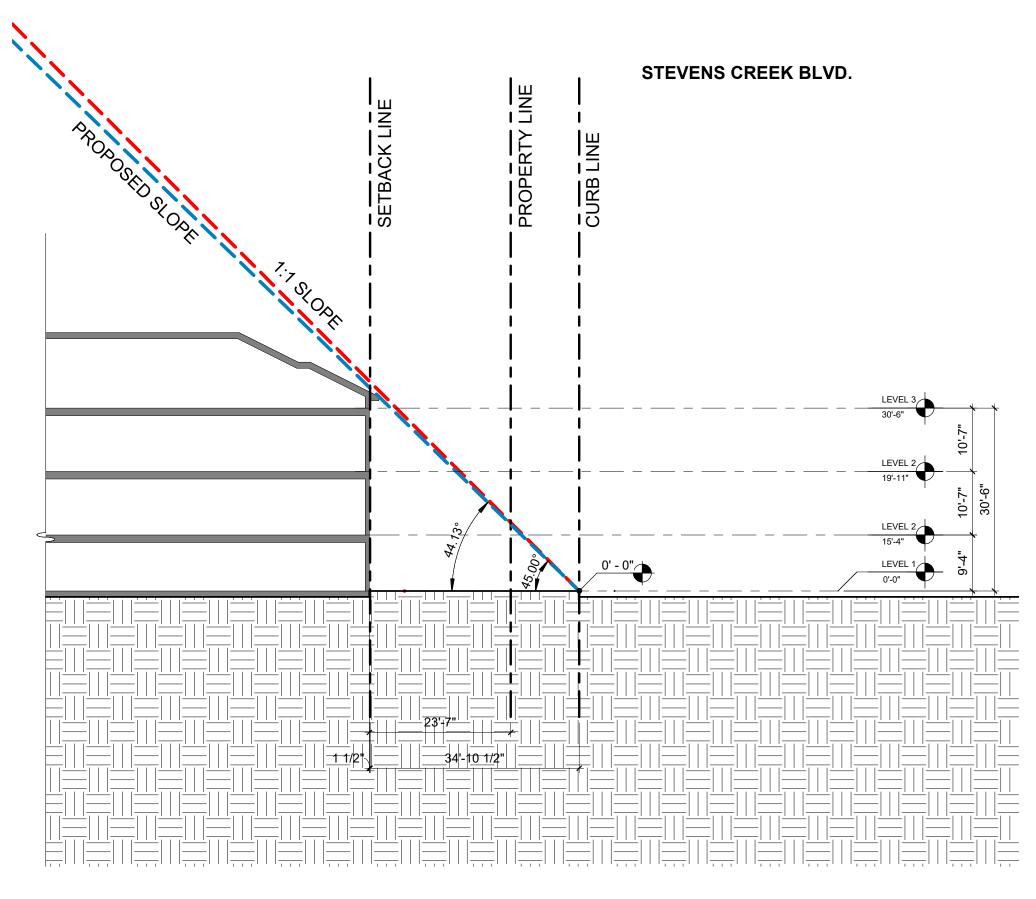



1 TOWNHOUSE G204 1/16" = 1'-0"

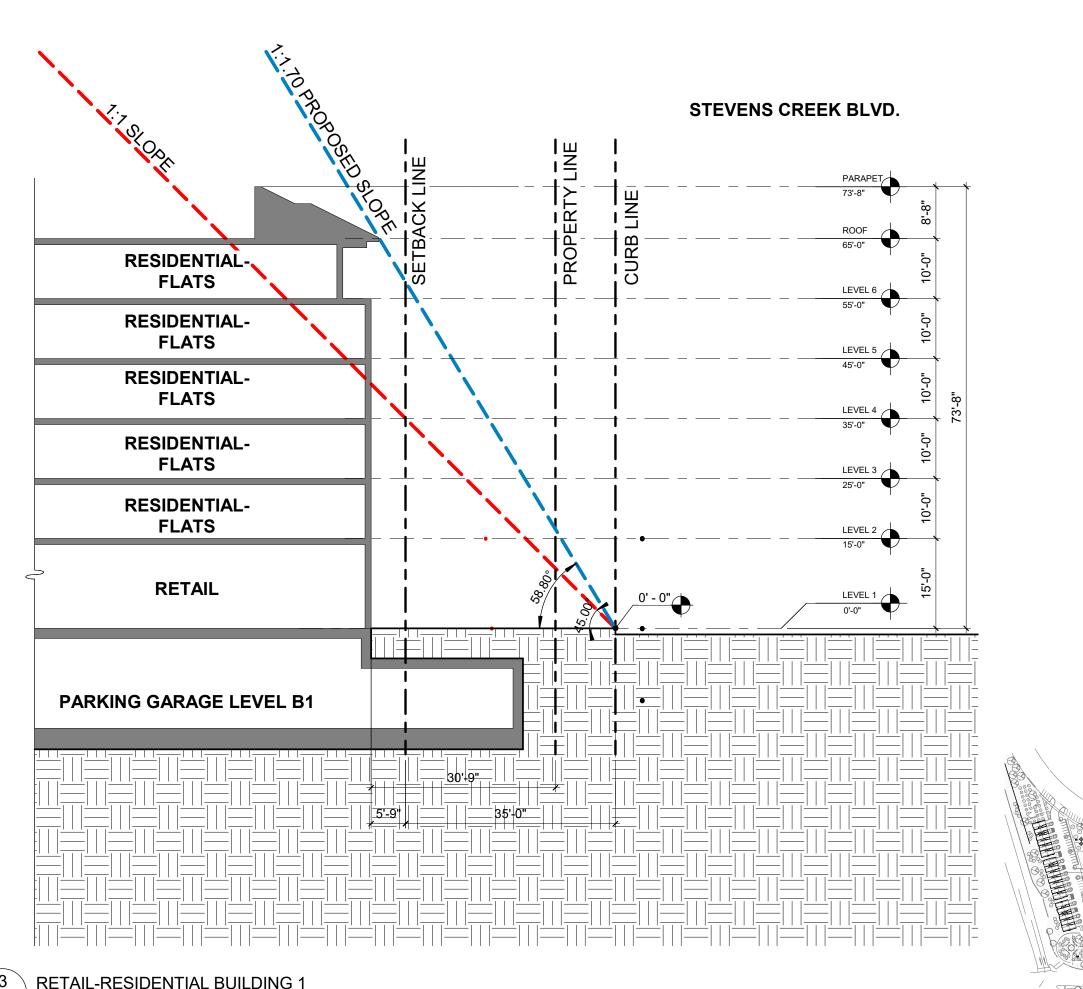


3 RETAIL-RESIDENTIAL BUILDING 1 G204 1/16" = 1'-0"

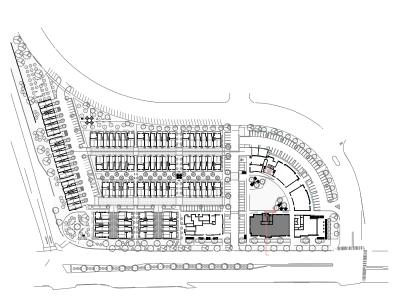


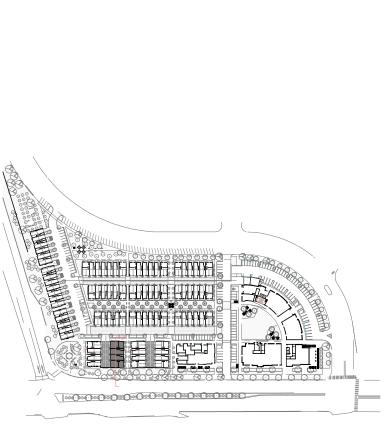

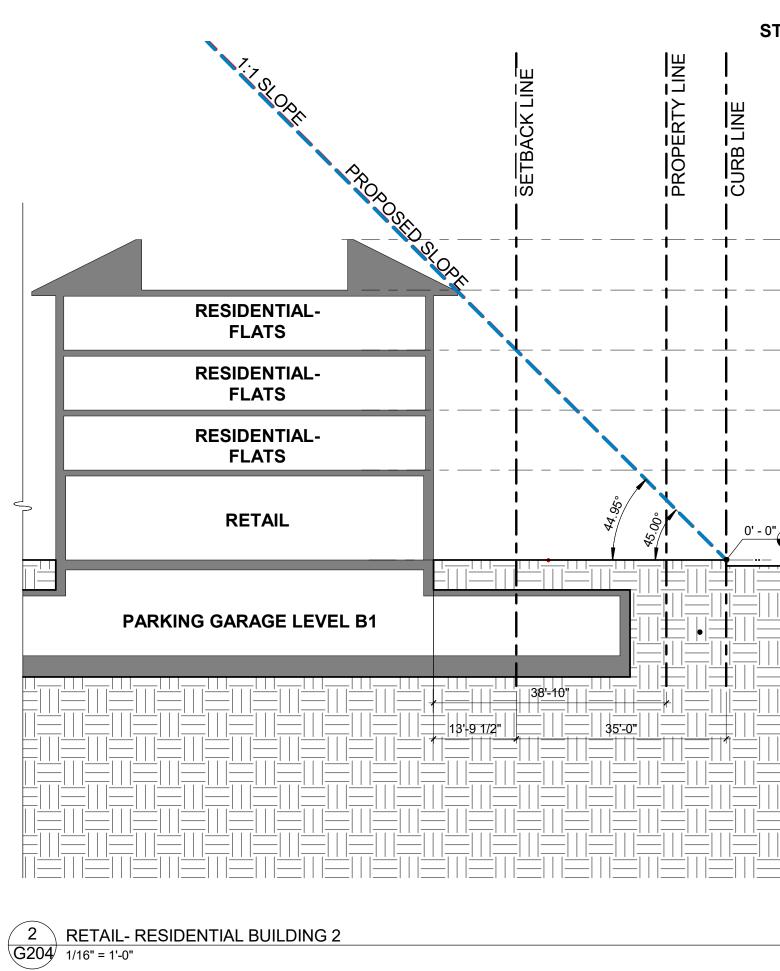

STEVENS CREEK BLVD.

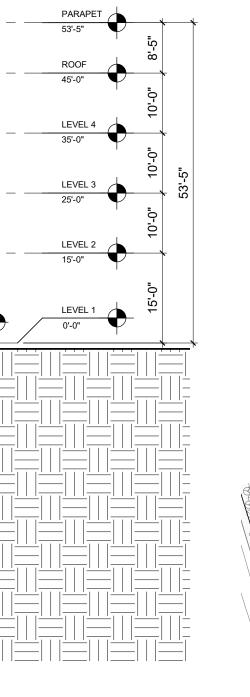

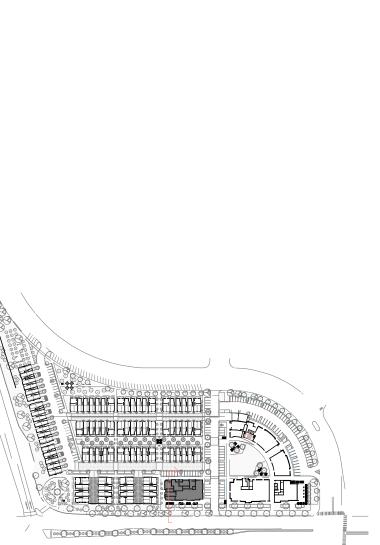



SHEET TITLE: **SLOPE SETBACKS** 

SHEET NO.:

PRELIMINARY, NOT FOR CONSTRUCTION REPRODUCTION OF THIS DRAWING IS EXPRESSLY FORBIDDEN WITHOUT THE SPECIFIC WRITTEN

REPRODUCTION OF THIS DRAWING IS EXPRESSLY FORBIDDEN WITHOUT THE SPECIFIC WRITTEN PERMISSION OF C2K ARCHITECTURE INC. THIS DRAWING IS ONLY CONDITIONALLY ISSUED, AND NEITHER RECEIPT OR POSSESSION THEREOF CONFERS OR TRANSFERS ANY RIGHT TO, OR LICENSE TO, USE THE SUBJECT MATTER OF THIS DRAWING OR ANY TECHNICAL INFORMATION SHOWN THEREON, NOR ANY RIGHT TO REPRODUCE THIS DRAWING OR PART THEREOF, WITHOUT THE WRITTEN AUTHORIZATION OF C2K ARCHITECTURE INC.

REVISION: DESCRIPTION:

PROJECT NO.: 14148

DRAWN: Author 2018 MAY 17 DATE: SITE PLAN APPLICATION

21267 STEVENS CREEK **BLVD, CUPERTINO, CA** 

**KT URBAN** 

## WESTPORT **CUPERTINO**

г — — — —	 ·	- — ¬
		I
1		I
I		I
I		
I		
I		I
I		I
I		
I		
I		
I		I
L CITY STAMP	 	








TH/RH PRIVATE OUTDOOR SPACE = 10,477 SF EACH RESIDENTIAL UNIT IS PROVIDED WITH A MINIMUM 60 SF PRIVATE OUTDOOR SPACE



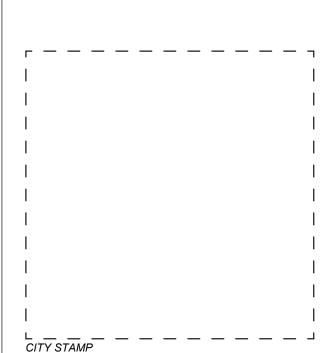



# **CUPERTINO**

**KT URBAN** 

PROJECT NO.: 14148

Author

REVISION: DESCRIPTION:

2018 MAY 17

DRAWN:

DATE:

ATION

APPLIC

Ζ

く

Ω

160'

20' 40'

0'

80'

SHEET TITLE:

SHEET NO.: G206

**OPEN SPACE AREAS** 

## 21267 STEVENS CREEK **BLVD, CUPERTINO, CA**

SITE PLAN APPLICATION

PRELIMINARY, NOT FOR CONSTRUCTION

REPRODUCTION OF THIS DRAWING IS EXPRESSLY FORBIDDEN WITHOUT THE SPECIFIC WRITTEN PERMISSION OF C2K ARCHITECTURE INC. THIS DRAWING IS ONLY CONDITIONALLY ISSUED, AND NEITHER RECEIPT OR POSSESSION THEREOF CONFERS OR TRANSFERS ANY RIGHT TO, OR LICENSE TO, USE THE SUBJECT MATTER OF THIS DRAWING OR ANY TECHNICAL INFORMATION SHOWN THEREON, NOR ANY RIGHT TO REPRODUCE THIS DRAWING OR PART THEREOF, WITHOUT THE WRITTEN AUTHORIZATION OF C2K ARCHITECTURE INC.



ATION APPLIC Ζ く Ω Ш S

SHEET TITLE: **NEIGHBORHOOD SITE PLAN &** 

SHEET NO.: **G207** 

**BUILDING HEIGHTS** 

PRELIMINARY, NOT FOR CONSTRUCTION

REPRODUCTION OF THIS DRAWING IS EXPRESSLY FORBIDDEN WITHOUT THE SPECIFIC WRITTEN PERMISSION OF C2K ARCHITECTURE INC. THIS DRAWING IS ONLY CONDITIONALLY ISSUED, AND NEITHER RECEIPT OR POSSESSION THEREOF CONFERS OR TRANSFERS ANY RIGHT TO, OR LICENSE TO, USE THE SUBJECT MATTER OF THIS DRAWING OR ANY TECHNICAL INFORMATION SHOWN THEREON, NOR ANY RIGHT TO REPRODUCE THIS DRAWING OR PART THEREOF, WITHOUT THE WRITTEN AUTHORIZATION OF C2K ARCHITECTURE INC.

REVISION: DESCRIPTION:

PROJECT NO.: 14148

DRAWN: Author 2018 MAY 17 DATE: SITE PLAN APPLICATION

**21267 STEVENS CREEK BLVD, CUPERTINO, CA** 


**KT URBAN** 

## WESTPORT **CUPERTINO**

CITY STAMP

ZK ARCHITECTURE INC 1645 NW HOYT PORTLAND OREGON 97209 503 444 2200

## **TOWNHOUSE / ROWHOUSE**

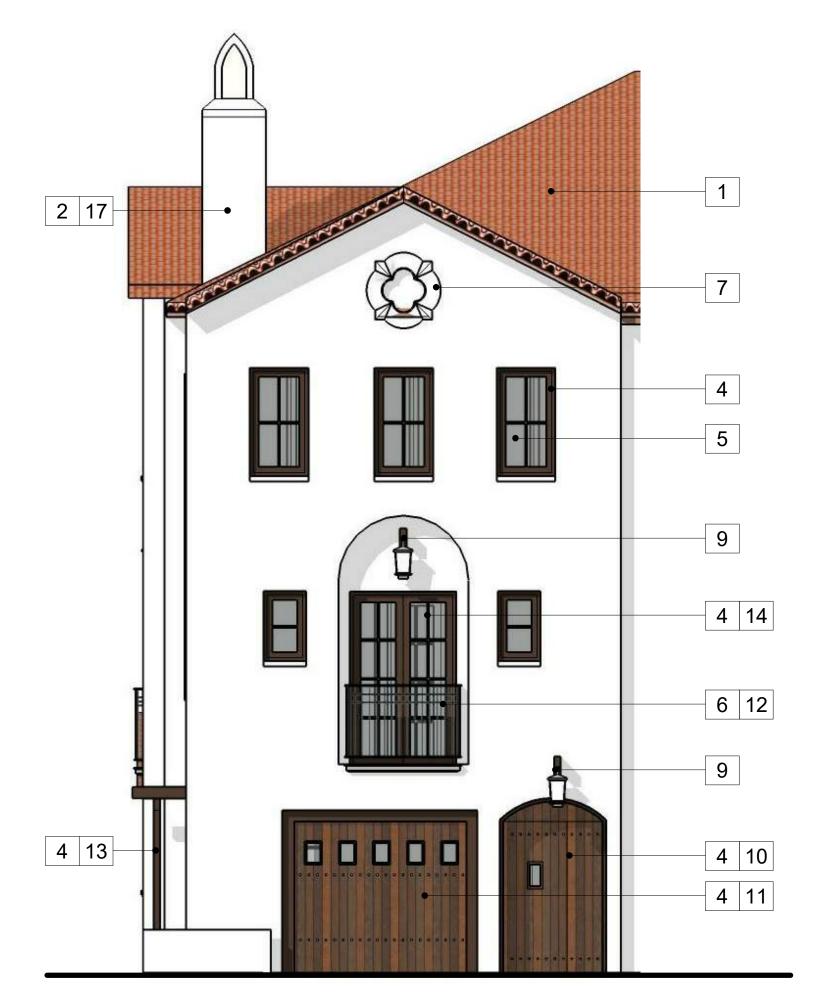

## MATERIAL LEGEND:

1. ROOF CEMENT TILE 2. STUCCO 3. STUCCO  $\bigcirc$ 7. PLASTER DETAILING 8. PAINTED METAL GUTTER / 6. PAINTED METAL ACCENT -DOWNSPOUT DARK BRONZE




**RETAIL / RESIDENTIAL** 





- 10. FRONT ENTRY
- 11. GARAGE
- 12. BALCONY / METAL RAILING
- 13. TRELLIS 14. FRENCH DOORS
- 15. SIGNAGE
- 16. CANOPY
- 17. "CHIMNEY" (PLUMBING / VENT STACKS)

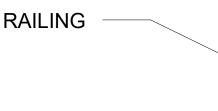



ATION APPLIC Ζ 4 ב SITE

SHEET NO ...

SHEET TITLE: **PROPOSED MATERIALS** 

**G213** 

REPRODUCTION OF THIS DRAWING IS EXPRESSLY FORBIDDEN WITHOUT THE SPECIFIC WRITTEN PERMISSION OF C2K ARCHITECTURE INC. THIS DRAWING IS ONLY CONDITIONALLY ISSUED, AND NEITHER RECEIPT OR POSSESSION THEREOF CONFERS OR TRANSFERS ANY RIGHT TO, OR LICENSE TO, USE THE SUBJECT MATTER OF THIS DRAWING OR ANY TECHNICAL INFORMATION SHOWN THEREON, NOR ANY RIGHT TO REPRODUCE THIS DRAWING OR PART THEREOF, WITHOUT THE WRITTEN AUTHORIZATION OF C2K ARCHITECTURE INC.

PRELIMINARY, NOT FOR CONSTRUCTION

DATE: REVISION: DESCRIPTION


PROJECT NO.: 14148

DRAWN: Author 2018 MAY 17 SITE PLAN APPLICATION

21267 STEVENS CREEK **BLVD, CUPERTINO, CA** 

**KT URBAN** 



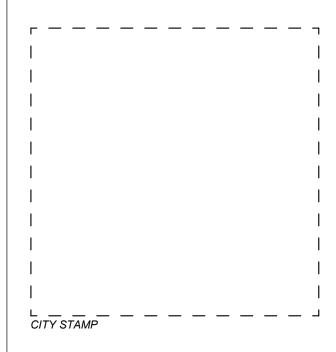

1645 NW HOYT PORTLAND OREGON 97209 503 444 2200



